

08.23.16

Harris Teeter
 Your Neighborhood Food and Pharmacy

HARRIS TEEETER
 STORE # 208
 COTSWOLD SHOPPING CENTER
 CHARLOTTE, NC


PROJECT MANAGER: Ryan Evans
 JOB NO: 15HT208-02
 DR. BY: JEN

| REVISIONS | No. | Date |
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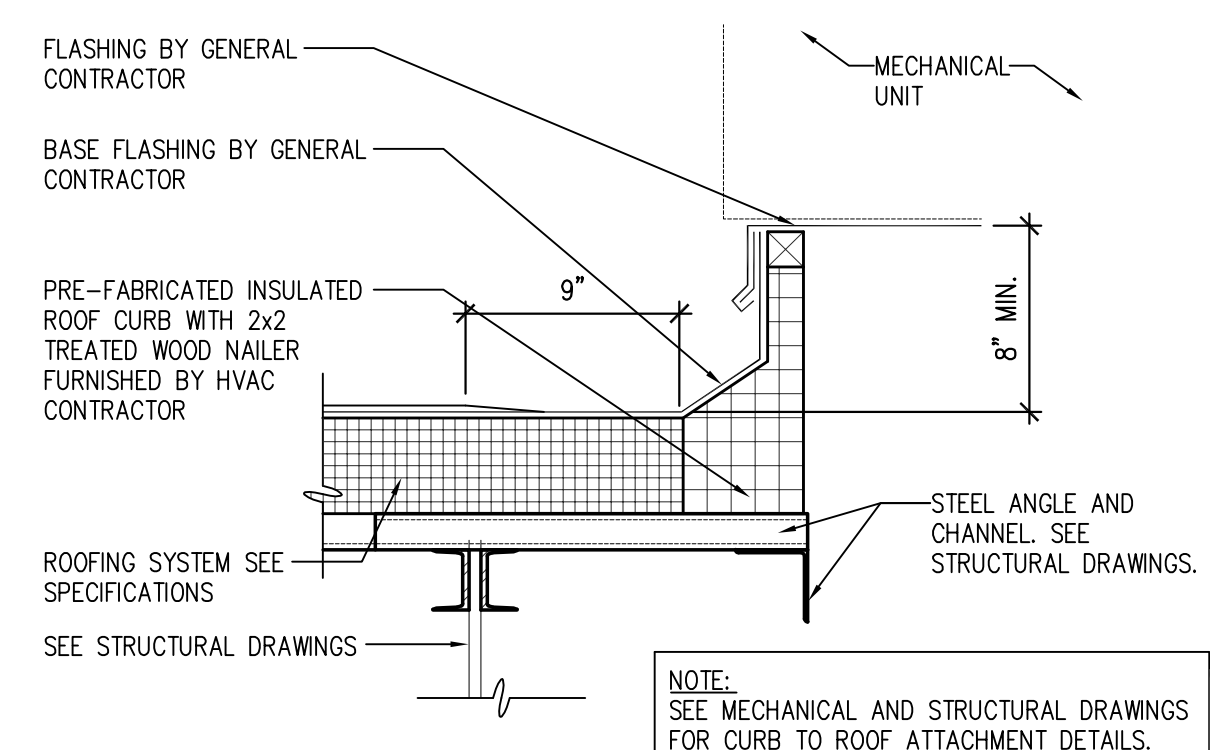
DRAWING NAME

ROOF PLAN
 SHEET NO. **A1.6**
 ISSUE DATE: 08.23.16


- GENERAL NOTES:**
1. THE G.C. SHALL COORDINATE THE EXACT SIZE AND LOCATIONS FOR ALL ROOF TOP PENETRATIONS FOR ALL PIPING, VENTS, CONDUITS, WIRING, ETC. THAT ARE TO PENETRATE TO ROOFING SYSTEM. THE G.C. IS TO INSTALL AND SEAL ALL ROOF PENETRATIONS. SEE DETAILS THIS SHEET FOR ADDITIONAL INFORMATION. SEE DETAIL 12/A1.6 FOR SINGLE OR MULTIPLE PIPE/CONDUIT PENETRATION DETAIL.
 2. G.C. SHALL BE RESPONSIBLE FOR PAINTING ALL EXPOSED STEEL ON ROOF TOP ON ALL SIDES ALONG WITH ALL ROOF TOP GAS PIPING, ROOF HATCH, SATELLITE POLES, ETC.
 3. G.C. SHALL BE RESPONSIBLE FOR REVIEWING ENGINEERING DRAWINGS AND VERIFYING ANY SEISMIC BRACING REQUIREMENTS AND COORDINATING THE INSTALLATION OF ANY REQUIRED BRACING.
- KEY NOTES:**
- 1 NEW CURB-MOUNTED ROOF TOP EQUIPMENT, SEE MECHANICAL DRAWINGS AND 4/A1.6.
 - 2 EMERGENCY SCUPPER LOCATION. MATCH EXISTING. SEE ELEVATIONS.
 - 3 NEW ROOFING SYSTEM TO MATCH EXISTING. COORDINATE EXACT LOCATION IN FIELD. SEE PLUMBING DRAWINGS.
 - 4 INTERNAL ROOF DRAIN. SLOPE ROOF INSULATION 1/2" PER FOOT TO DRAIN. TYPICAL. COORDINATE WITH PLUMBING DRAWINGS.
 - 5 NEW INTERNAL ROOF OVERFLOW DRAIN. COORDINATE WITH PLUMBING DRAWINGS.
 - 6 EXISTING REFRIGERATION EQUIPMENT ON STRUCTURAL STEEL FRAMES TO REMAIN.
 - 7 EXISTING ROOF TO REMAIN. SEE STRUCTURAL DRAWINGS.
 - 8 EXISTING CURB MOUNTED ROOF TOP EQUIPMENT TO REMAIN.
 - 9 PARAPET AND METAL COPING. SEE DETAIL 5/A1.6.
 - 10 TAPERED ROOF CRICKETS AS REQUIRED.
 - 11 EXISTING INTERNAL ROOF DRAIN.

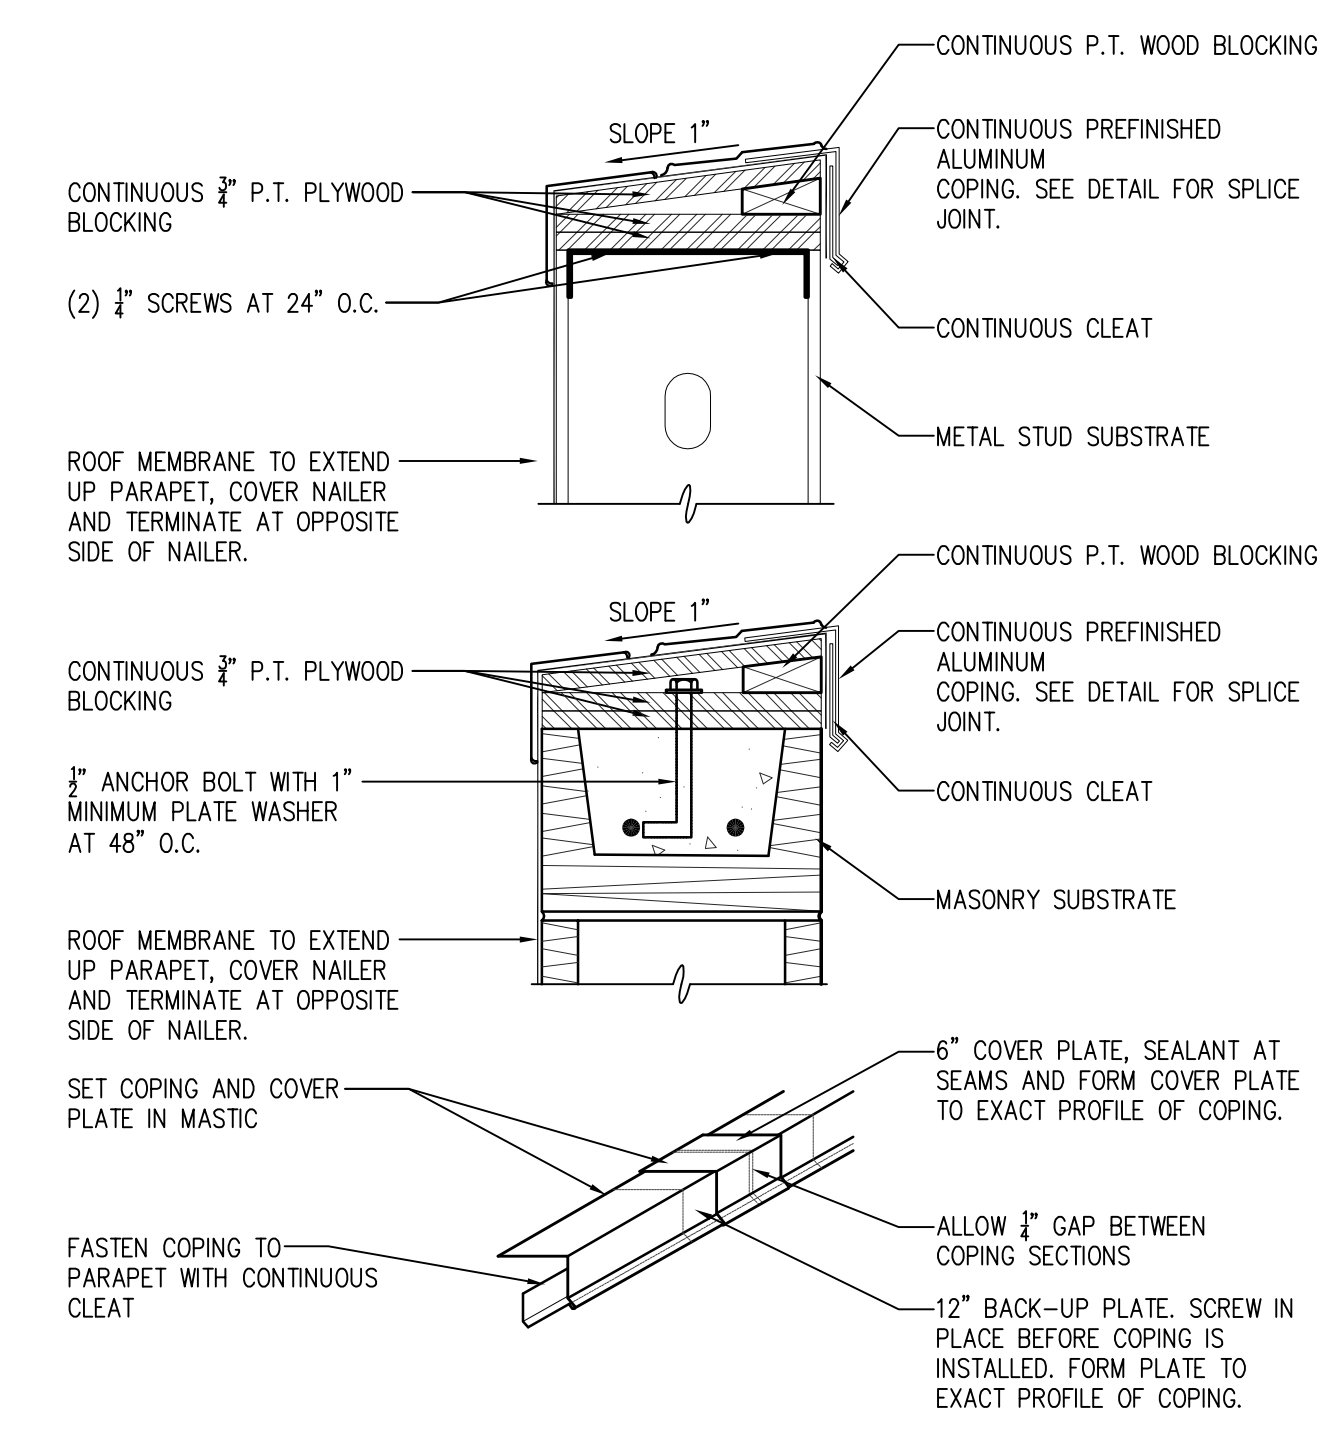


5 DETAIL AT METAL COPING
 SCALE: 1 1/2" = 1'-0"




4 DETAIL AT TYPICAL ROOF CURB
 SCALE: 1 1/2" = 1'-0"

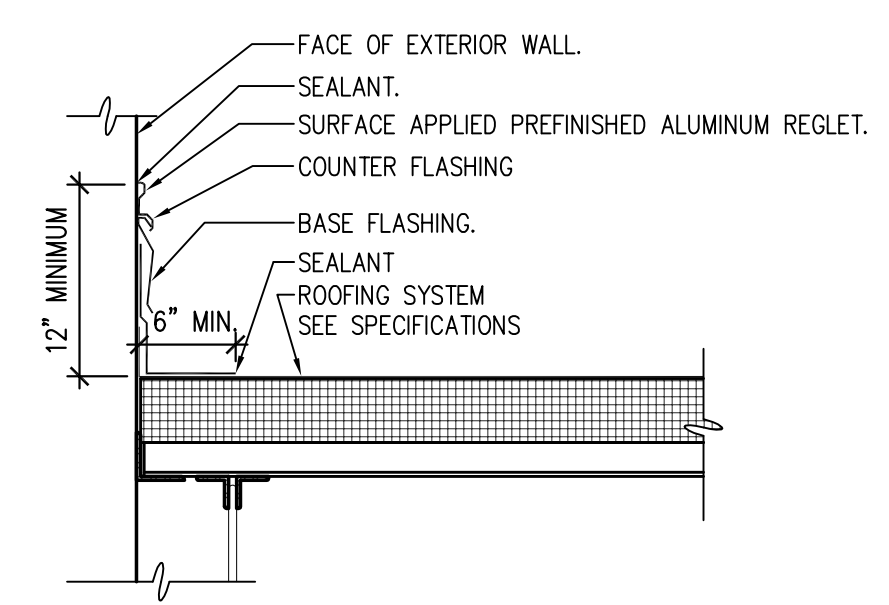


10 SECTION AT ROOF FLASHING
 SCALE: 1" = 1'-0"

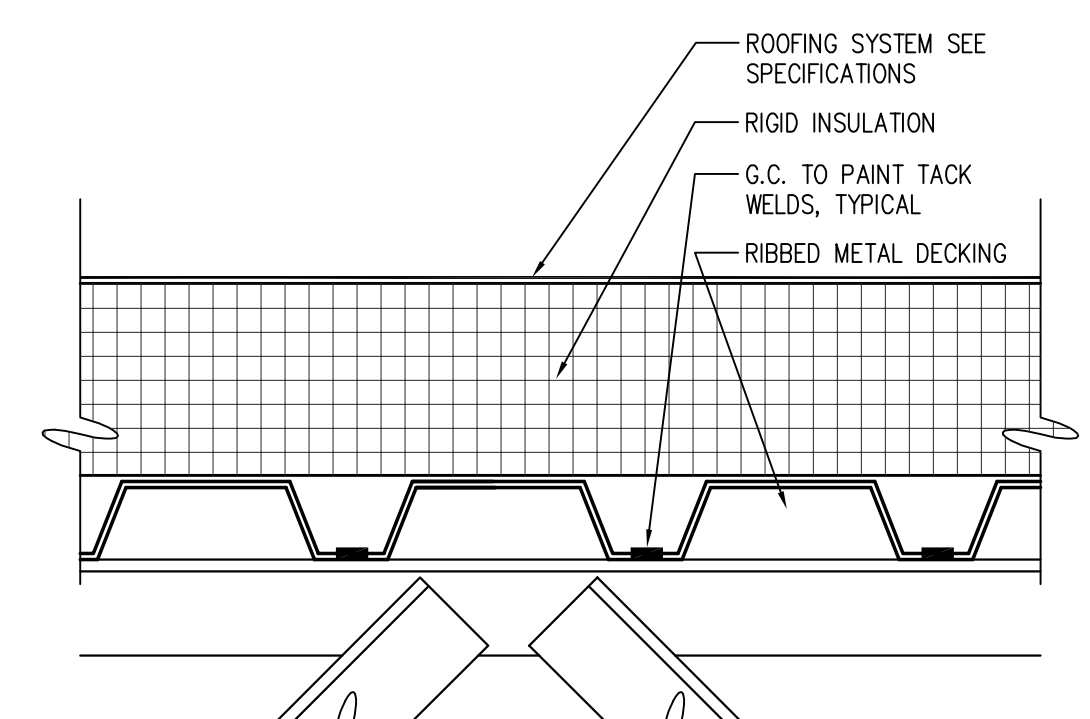

8 SECTION AT ROOF DECK
 SCALE: 3" = 1'-0"

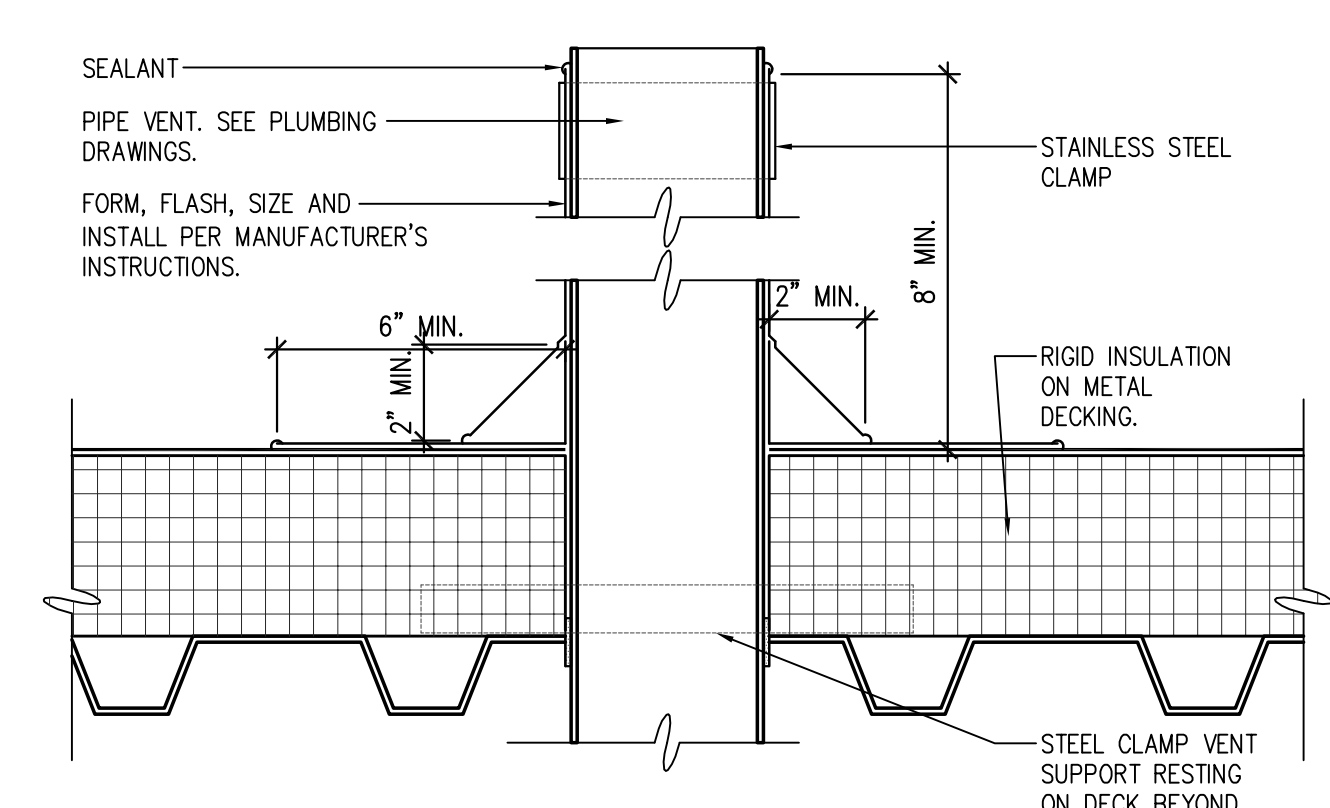

7 SECTION AT ROOF VENT PIPE
 SCALE: 3" = 1'-0"

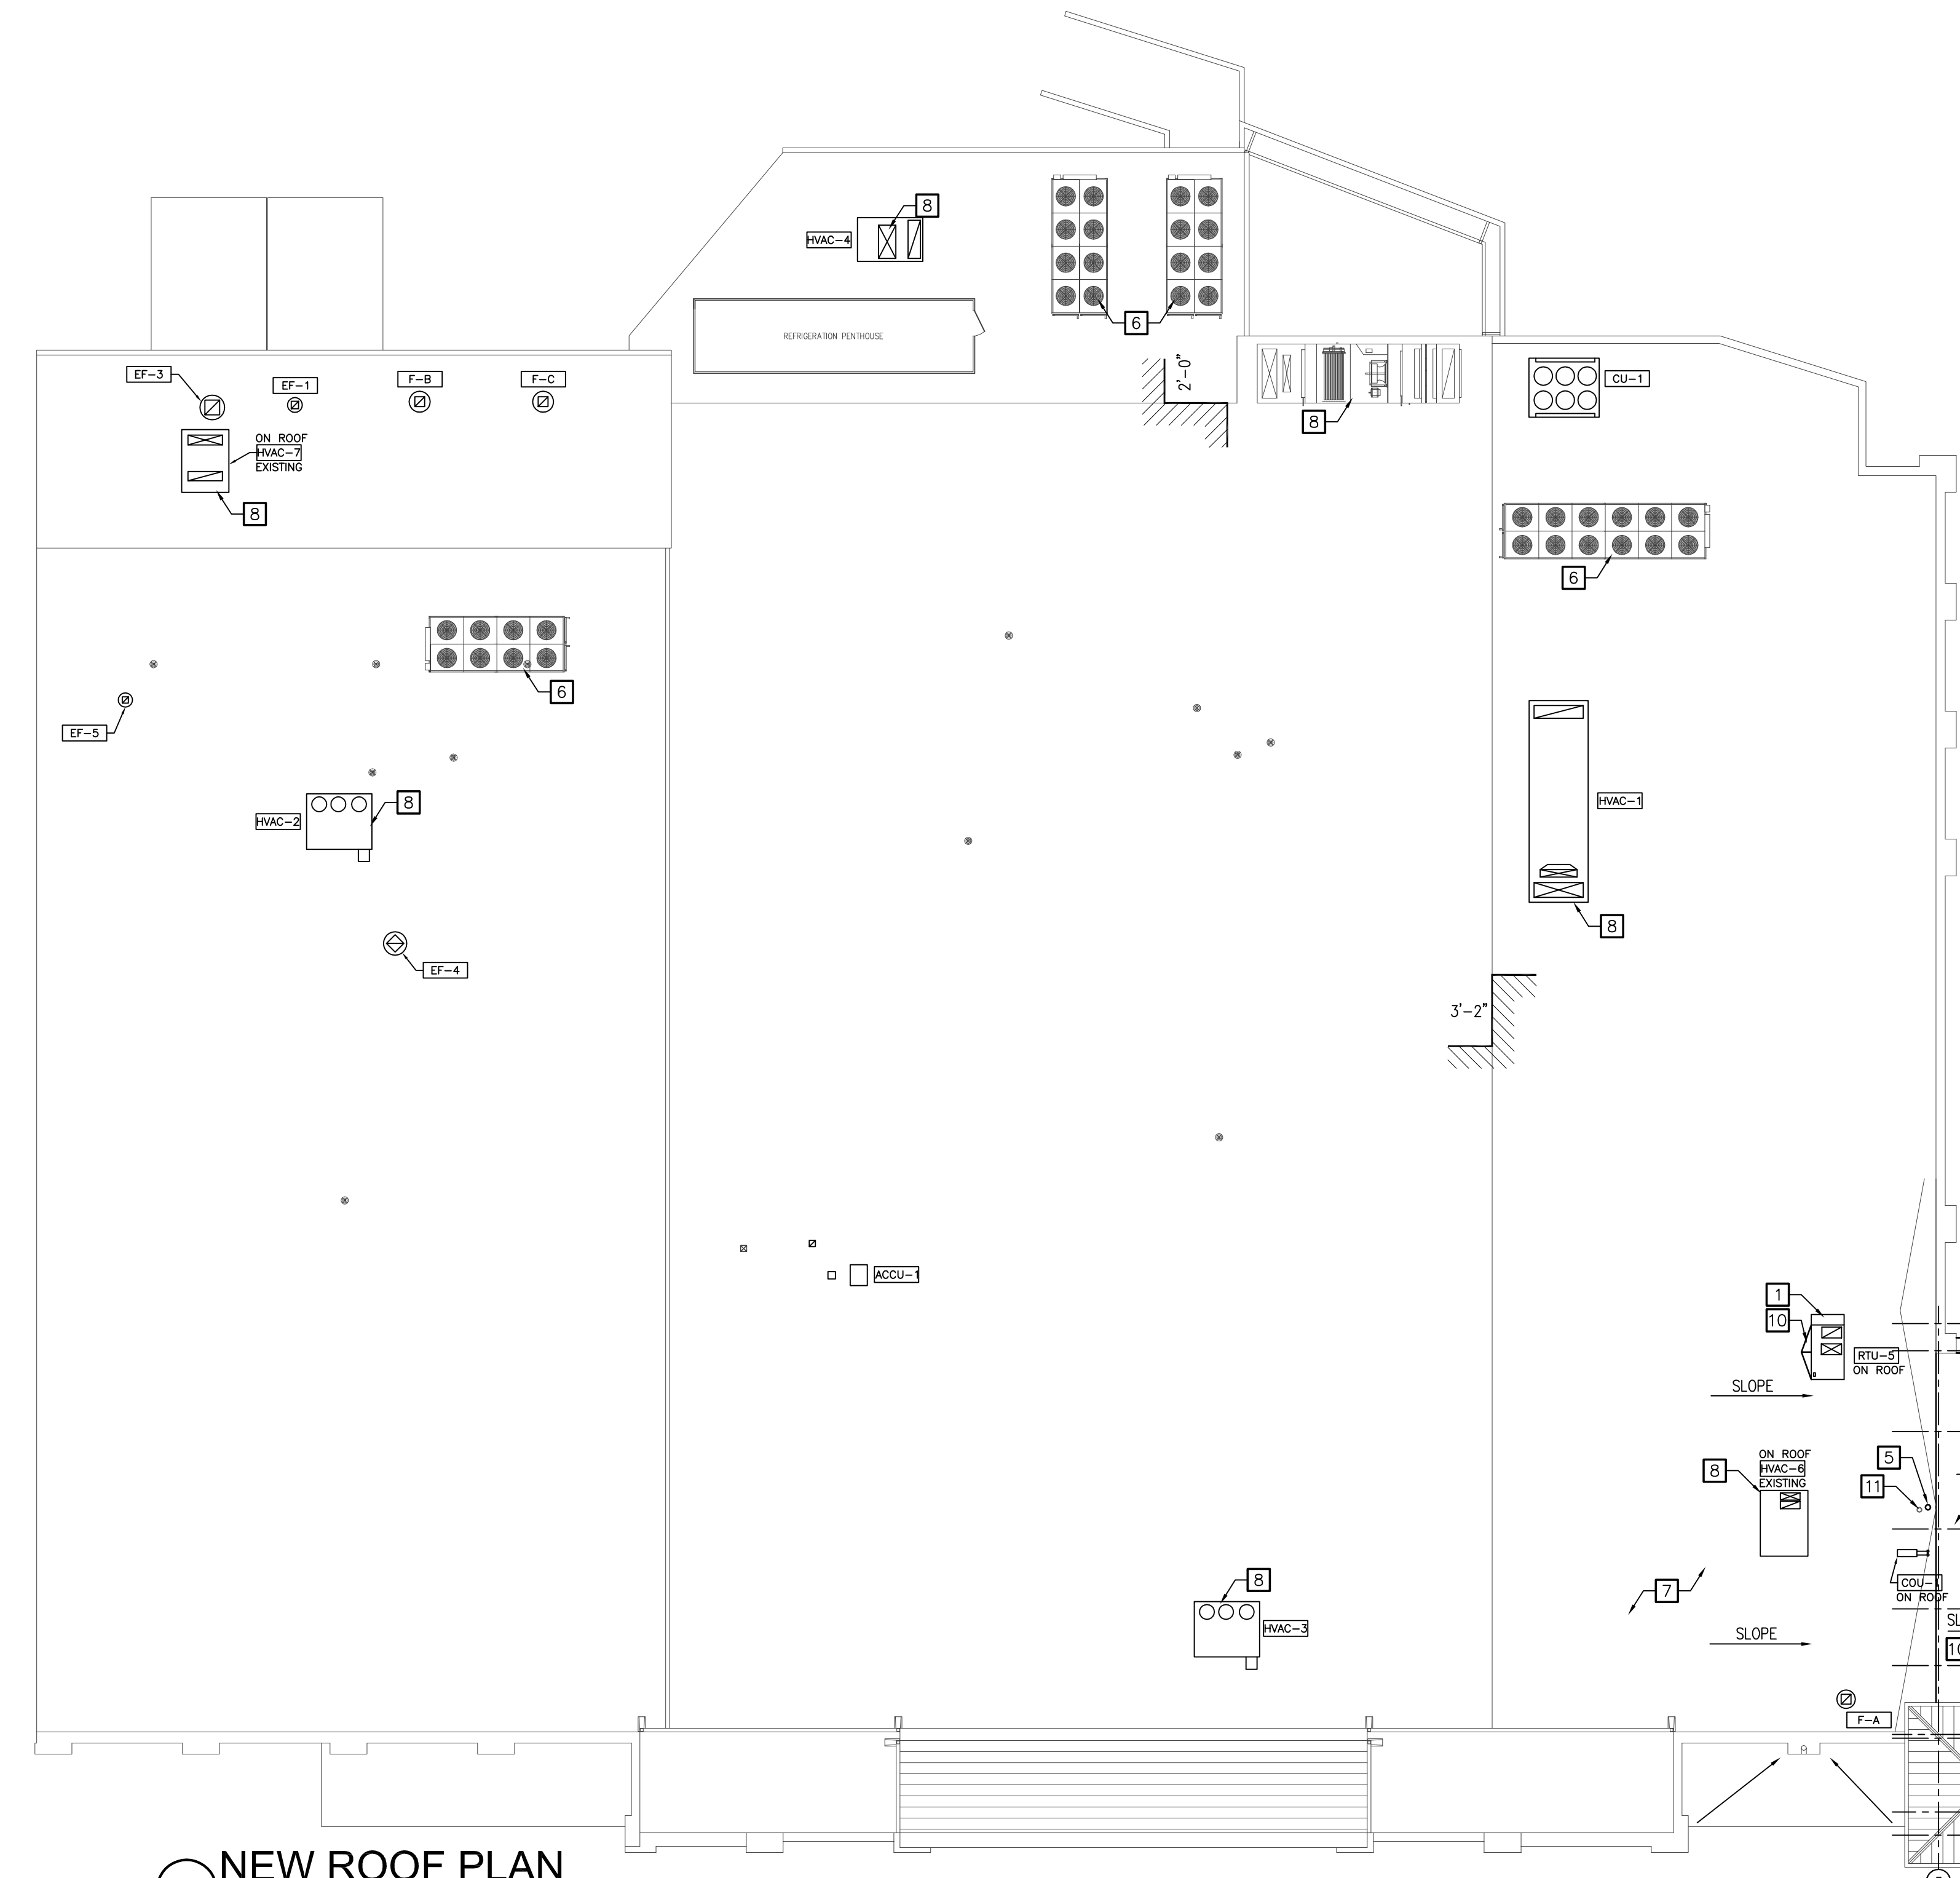

1 NEW ROOF PLAN
 SCALE: 1/16" = 1'-0"